


2 REFLECTED CEILING PLAN- FLOOR 1


SCALE: 1/4" = 1'-0"

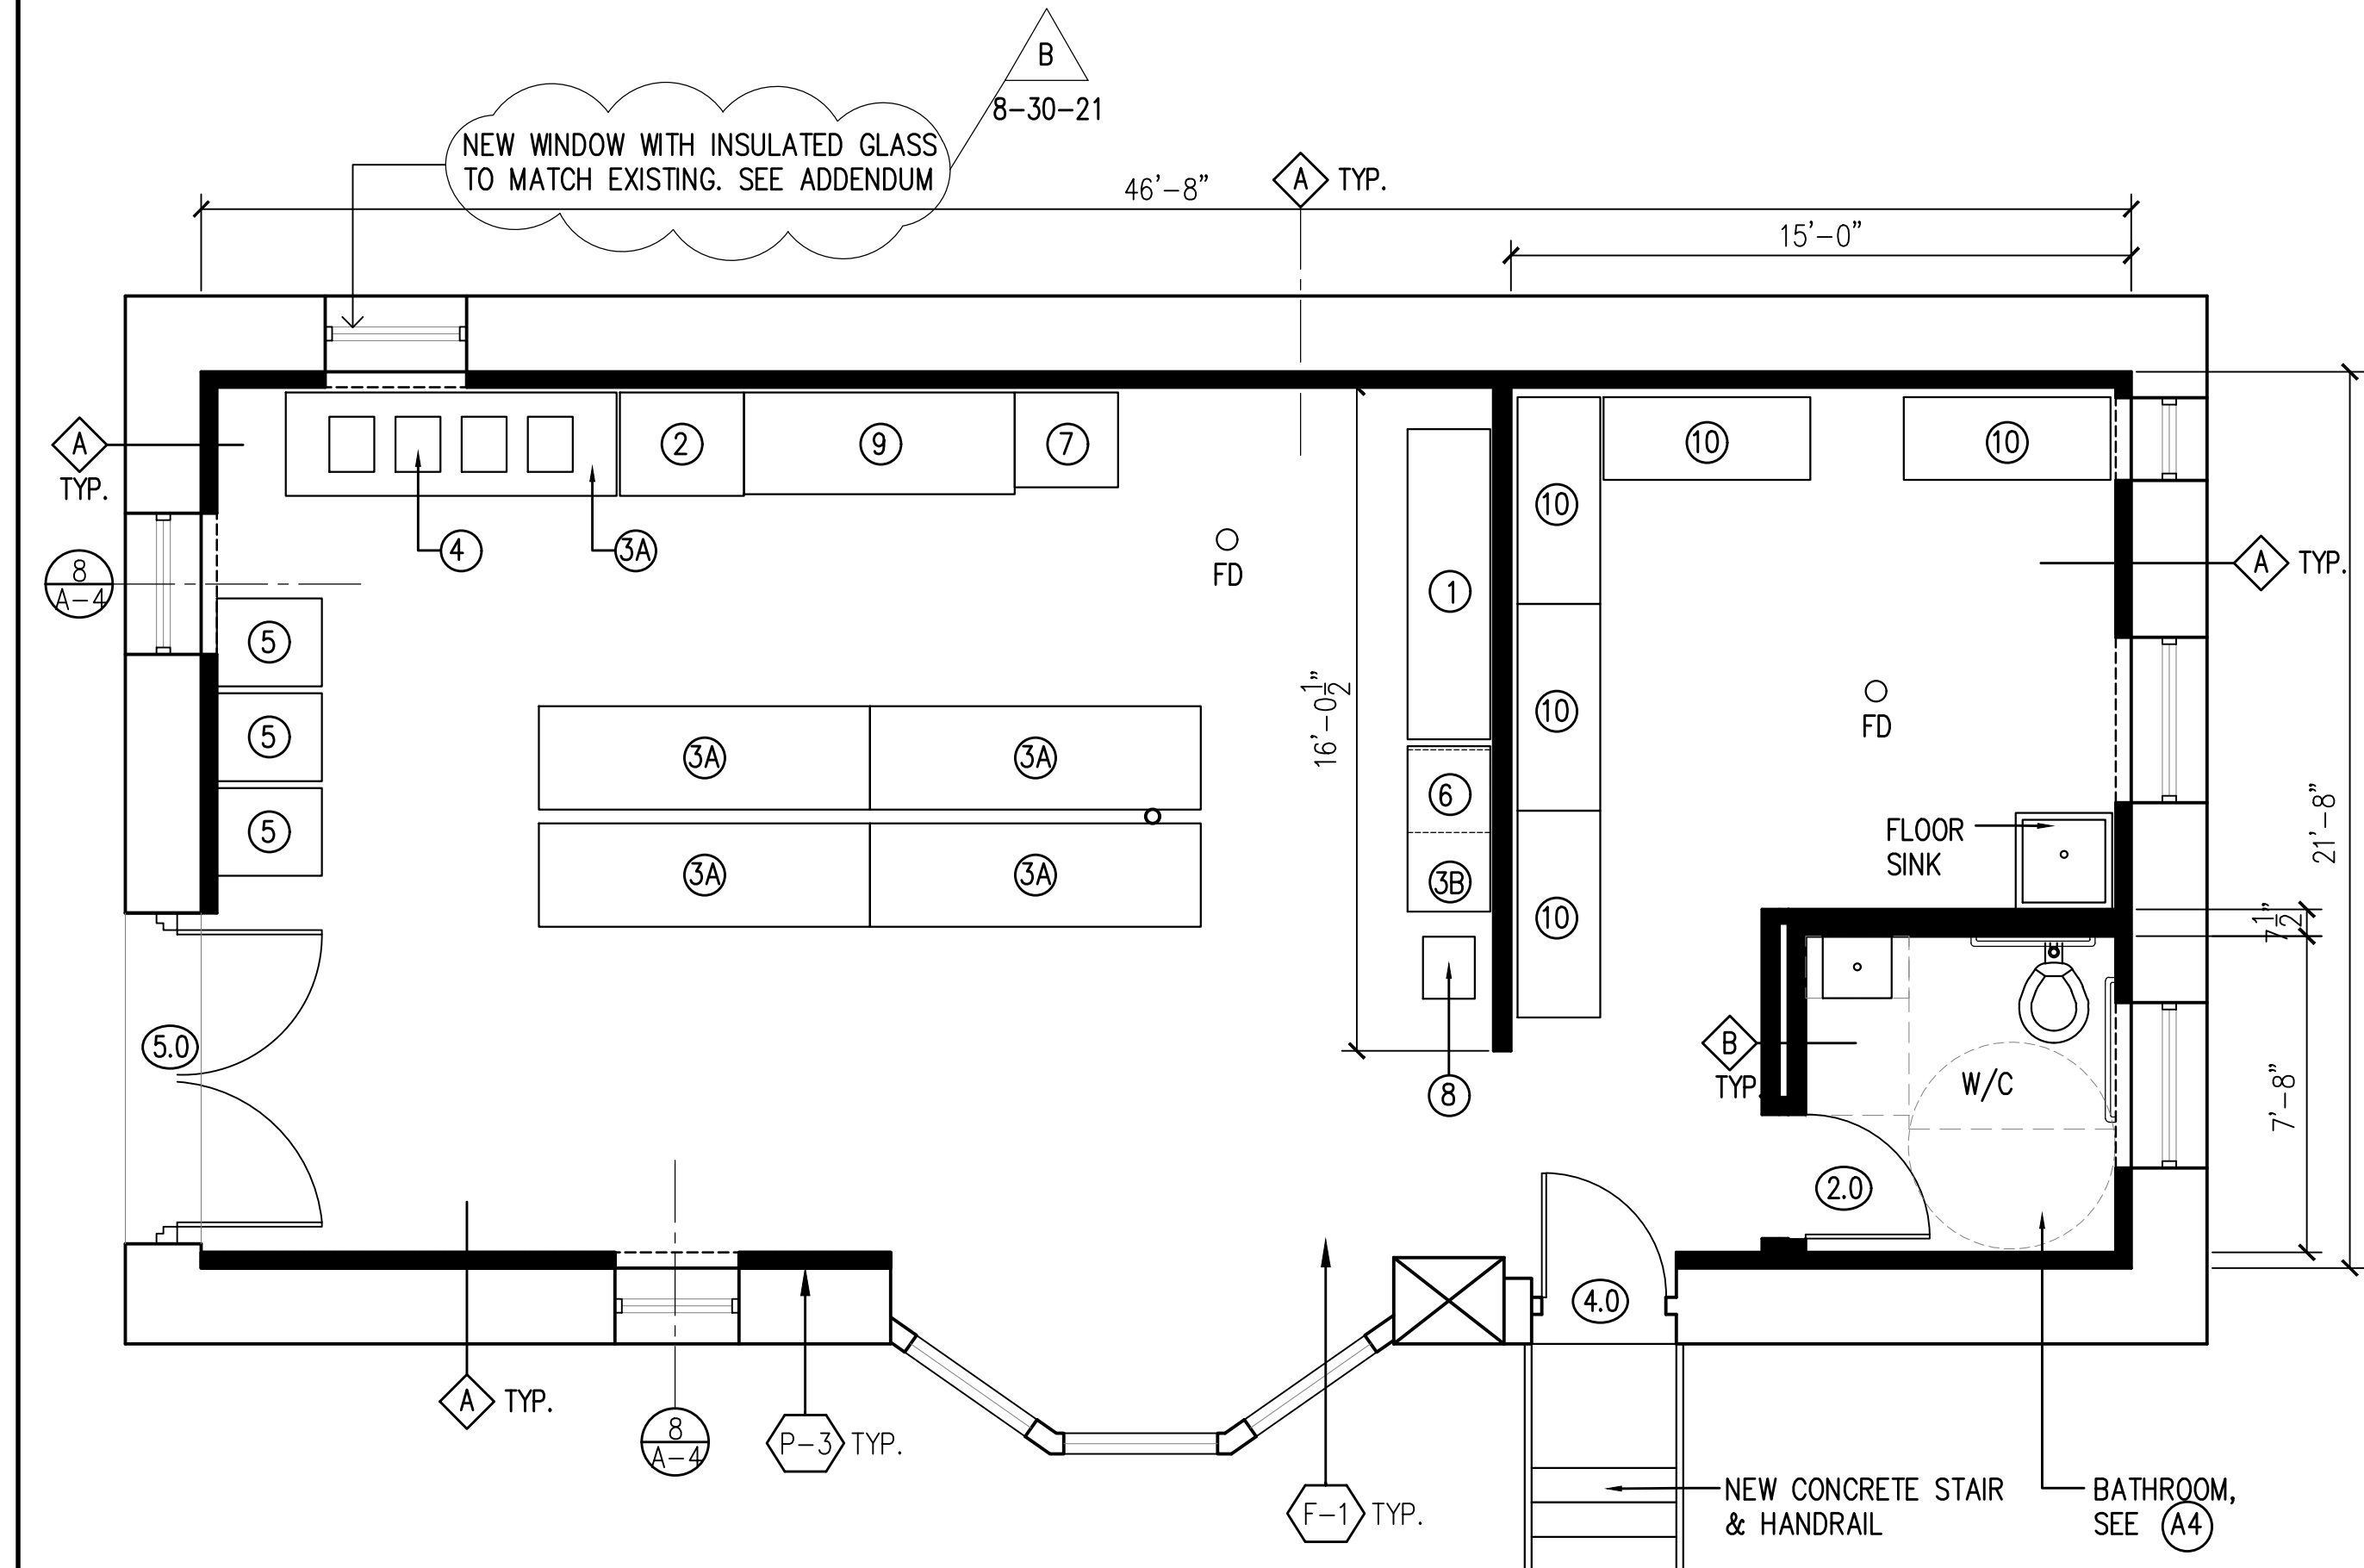

1 1ST FLOOR PLAN


SCALE: 1/4" = 1'-0"

LIGHTING SCHEDULE		
FIXTURE TYPE	DESCRIPTION	MANUFACTURER/ CATALOGUE #
A	6" LED DOWNLIGHT	FOCAL POINT-FLC6D-RO-2000L-120V-LD1-T-LC6-RD-2000L-3000K-80+, 30K-DN-WD-WP
B	6" LED DOWNLIGHT, IC	PRESCOLITE LTR-6RD-H-ML-20L-DM1-STANDARD 120-277V-IC-LTR-6RD-T-ML-30K-8-XW-VS-WT
C	SCONCE	BEGA #66411-K3-BLK

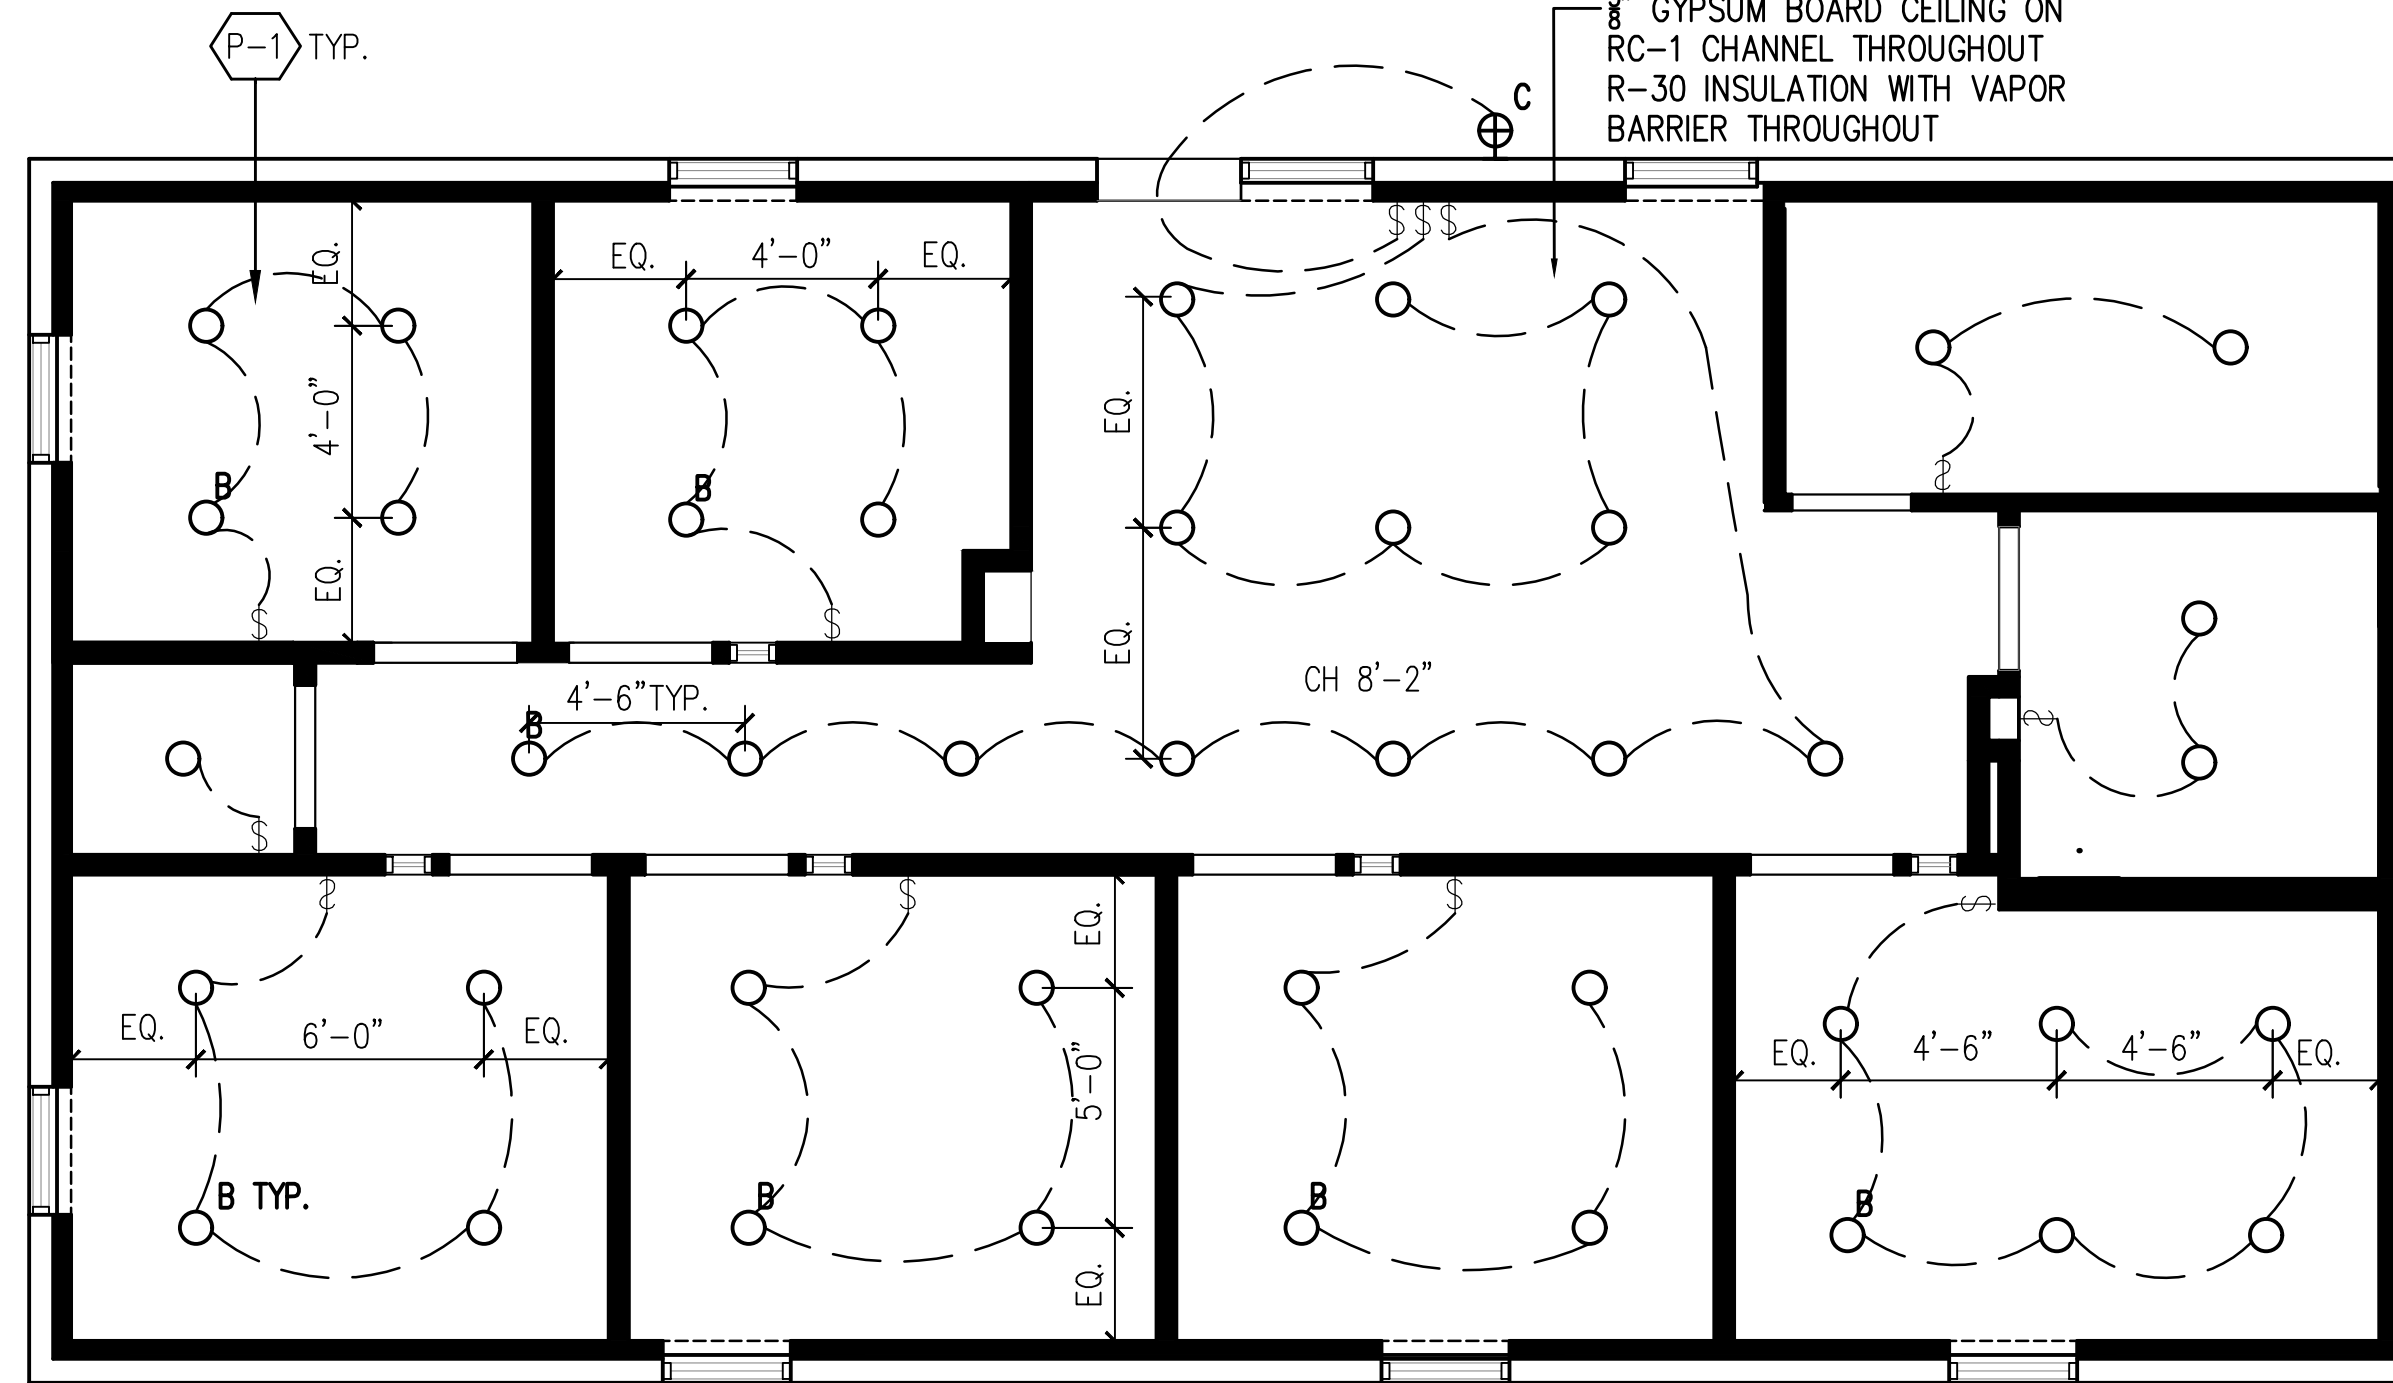

3 REFLECTED CEILING PLAN- FLOOR 2

SCALE: 1/4" = 1'-0"

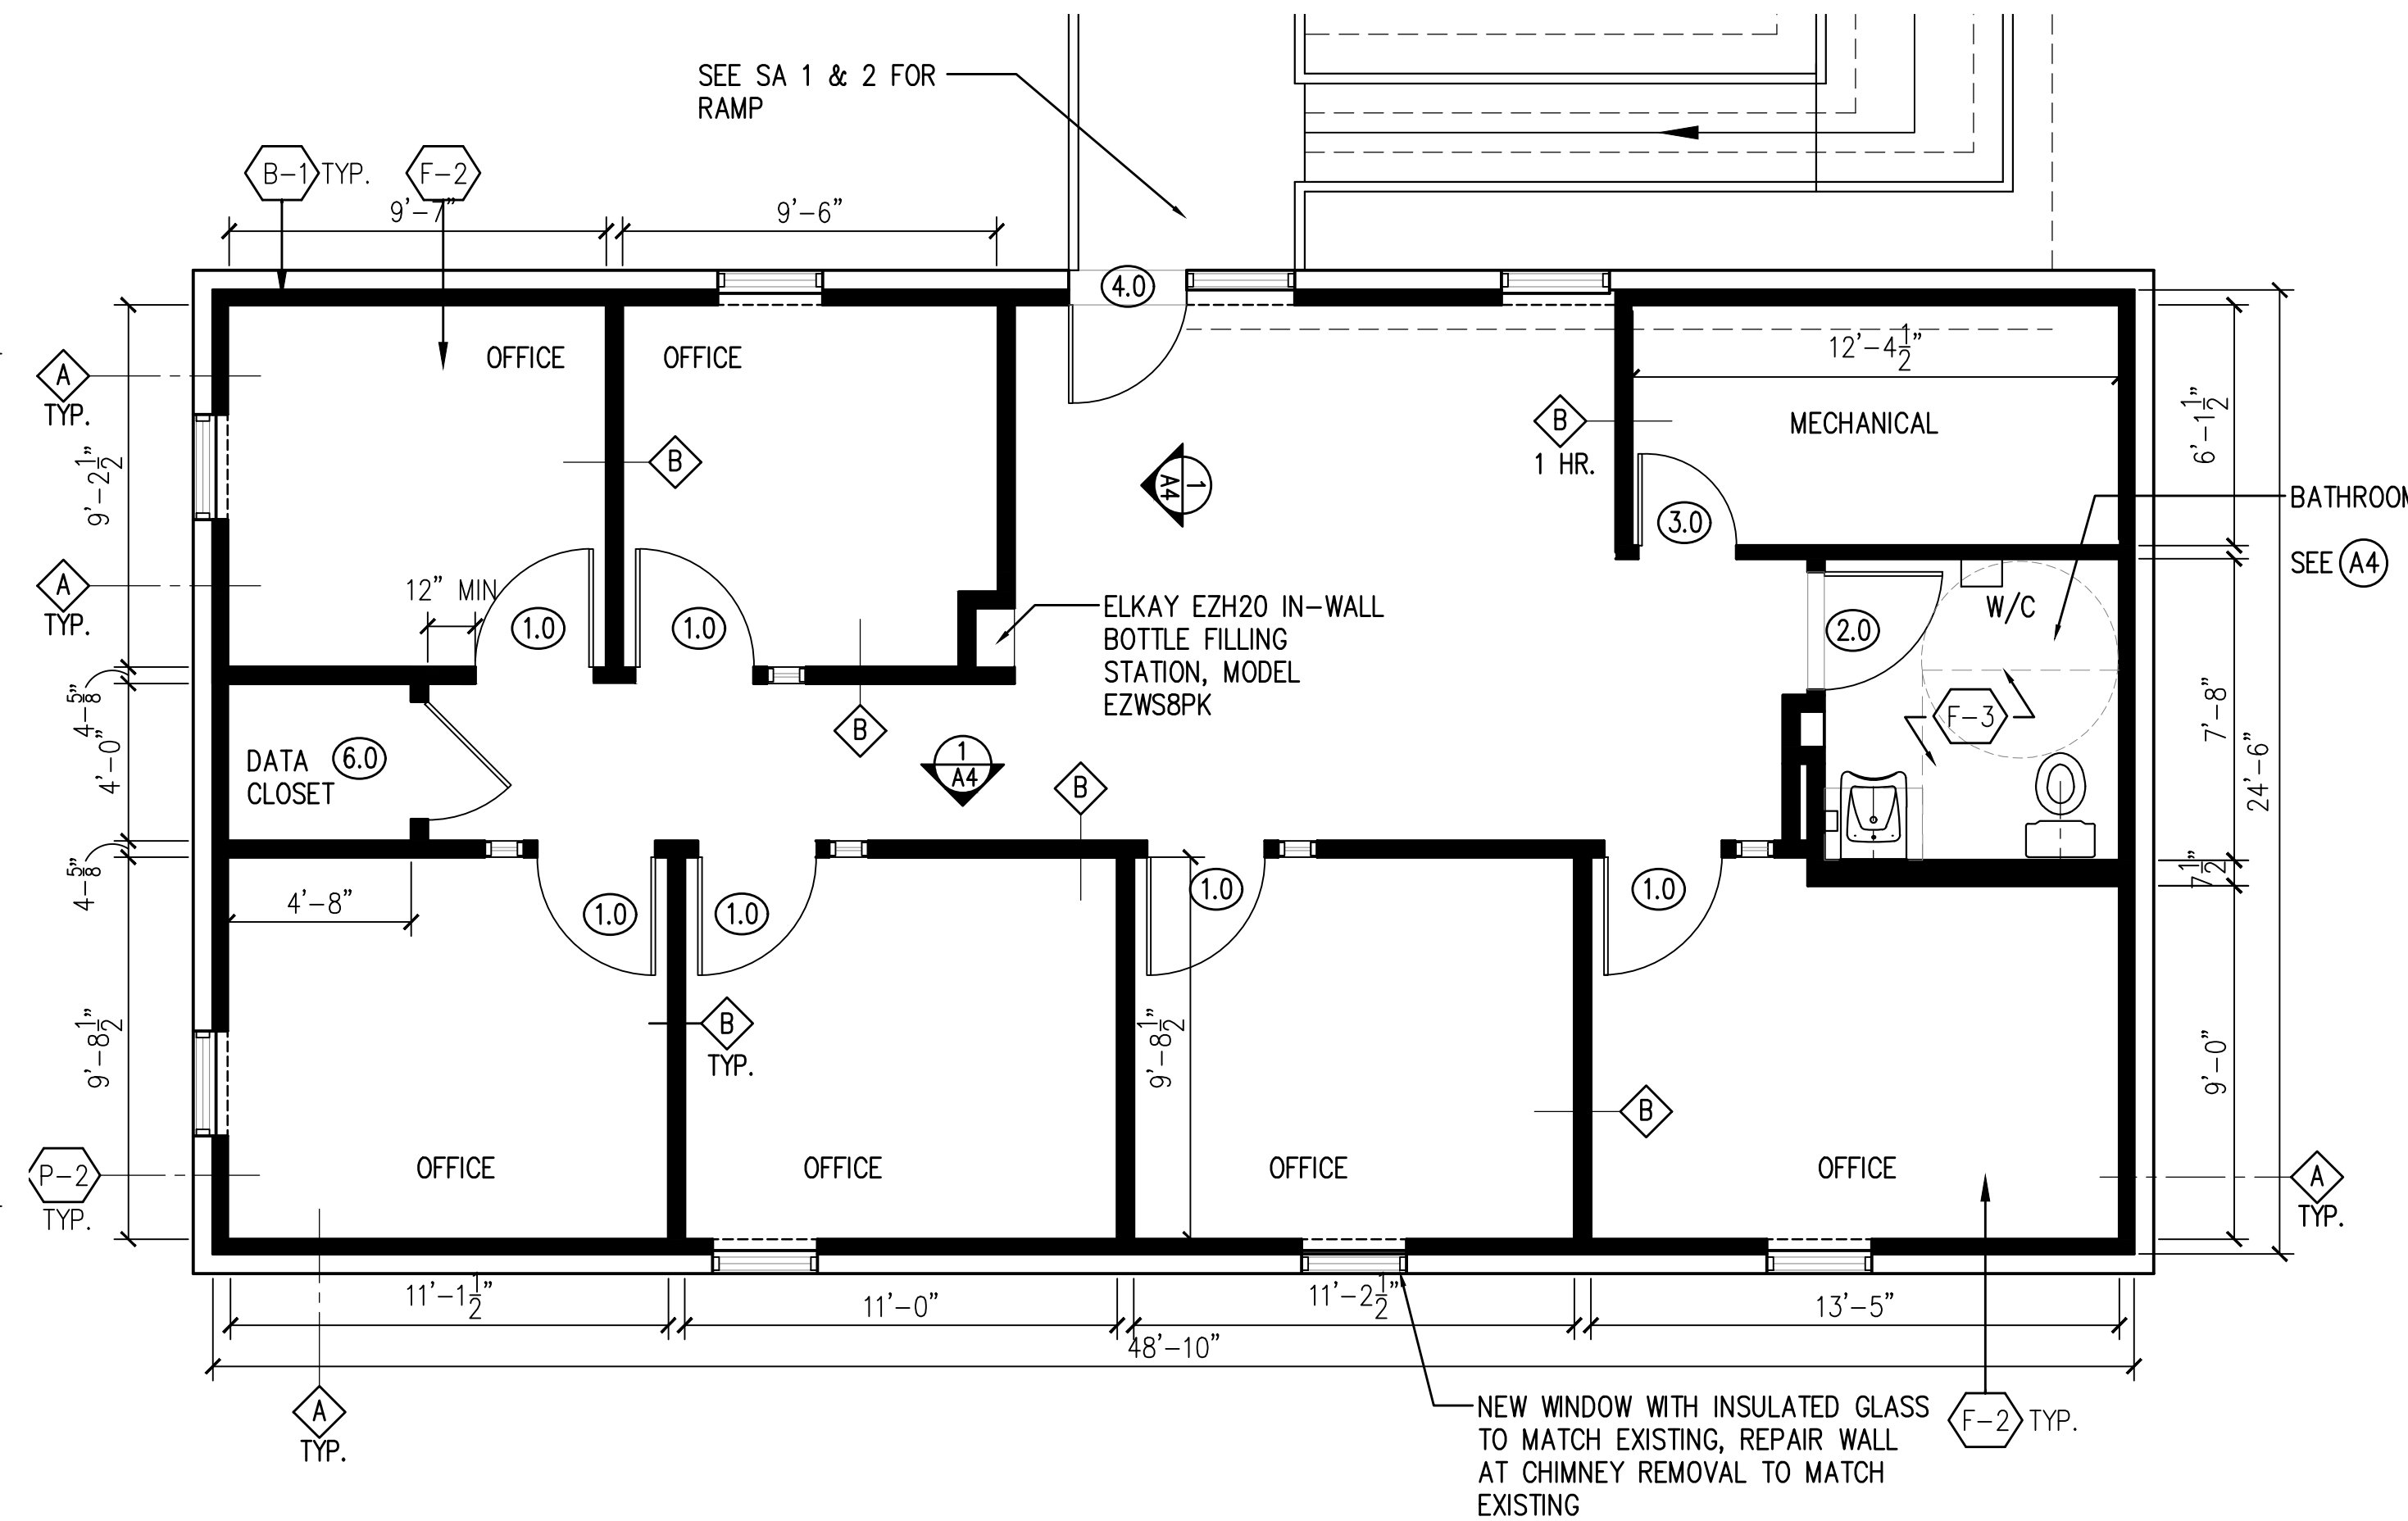

4 2ND FLOOR PLAN

SCALE: 1/4" = 1'-0"

B-1 WALL BASE
ROPPE 700 SERIES WALL BASE 4 1/2"
HT STANDARD TOE BASE
COLOR: 123 CHARCOAL

MATERIAL SCHEDULE

- F-1 FLOORING**
DAL TILE CC 0701
FINISH: TEXTURED
SIZE: 6" X 6"
INSTALLATION: MUDSET
NOTE: PREPARE FLOOR WITH SELF-LEVELING CONCRETE
BASE: COVE BASE AT PERIMETER TYP.
- F-2 FLOORING**
INTERFACE STUDIO SET LVT TILE A007
COLOR: A00702 PEWTER
INSTALLATION: ADHESIVE ON 1 LAYER 3/4" PLYWOOD SUBFLOOR OR CONCRETE IN ACCORDANCE WITH MANUFACTURERS RECOMMENDATIONS
BASE: RUBBER COVE BASE AT PERIMETER TYP.
- F-3 FLOORING**
AMERICAN OLEAN CC67, ELEGANT GRAY GLAZED PORCELAIN
FINISH: MATTE
SIZE: 12" X 12"
BASE: PROVIDE ALCOVE BASE
- W-1 WALL TILE**
AMERICAN OLEAN 66SAM 0091, BISCUIT
FINISH: MATTE
SIZE: 6" X 6"
BASE: BULLNOSE & CORNER BULLNOSE
- C-1 CEILING**
ARMSTRONG CALLA HEALTH ZONE TILE
SIZE: 2'-0" X 2'-0" X 1"
INSTALLATION: SUSPENSION SYSTEM PRELUDE 1 5/8" SQUARE LAY IN
FINISH: SMOOTH TEXTURE
- P-1 PAINT (CEILINGS)**
1ST COAT: BENJAMIN MOORE ULTRA SPEC 500 INTERIOR LATEX PRIMER N534
2ND COAT: BENJAMIN MOORE ULTRA SPEC 500 INTERIOR LATEX FLAT N536
3RD COAT: BENJAMIN MOORE UNTRA SPEC 500 INTERIOR LATEX FLAT N536
- P-2 PAINT (OFFICE WALLS/ COMMON AREAS)**
1ST COAT: BENJAMIN MOORE ULTRA SPEC 500 INTERIOR LATEX PRIMER N534
2ND COAT: BENJAMIN MOORE ULTRA SPEC 500 INTERIOR LOW SHEEN N537
3RD COAT: BENJAMIN MOORE ULTRA SPEC 500 INTERIOR LOW SHEEN N537
PROVIDE 2'-0" X 2'-0" MOCK UP FOR OWNER APPROVAL
- P-3 PAINT (KITCHEN WALLS)**
1ST COAT: BENJAMIN MOORE ULTRA SPEC 500 INTERIOR LATEX PRIMER N534
2ND COAT: COROTECH ACRYLIC EPOXY V450
3RD COAT: COROTECH ACRYLIC EPOXY V450
PROVIDE 2'-0" X 2'-0" MOCK UP FOR OWNER APPROVAL
- P-4 PAINT (METAL)**
1ST COAT: BENJAMIN MOORE SUPER SPEC HP ACRYLIC METAL PRIMER P04
2ND COAT: BENJAMIN MOORE ULTRA SPEC 500 INTERIOR LATEX GLOSS N540
3RD COAT: BENJAMIN MOORE ULTRA SPEC 500 INTERIOR LATEX GLOSS N540

PETER JOHNSTON, ARCHITECT, PC
84 WASHINGTON STREET 2ND FLOOR
HOBOKEN N.J. 07030
N.J. LICENSE AIO 13073

PROJECT: UNIVERSITY MAIN CAMPUS
CARRIAGE HOUSE
WILLIAM PATERSON UNIVERSITY
WAYNE, NJ 07470

TITLE: RCP
FLOOR PLANS

ZONING: DATE: 04-27-2021
REV: SCALE: As Noted
BID SET 07-30-2021
8-30-2021
DRAWN BY: Y.B.
DRAWING NO:

A3